

The Dennis Farm Charitable Land Trust


THE DENNIS HOUSE RESTORATION

The Historic Dennis Farm

Kingsley, PA 18826

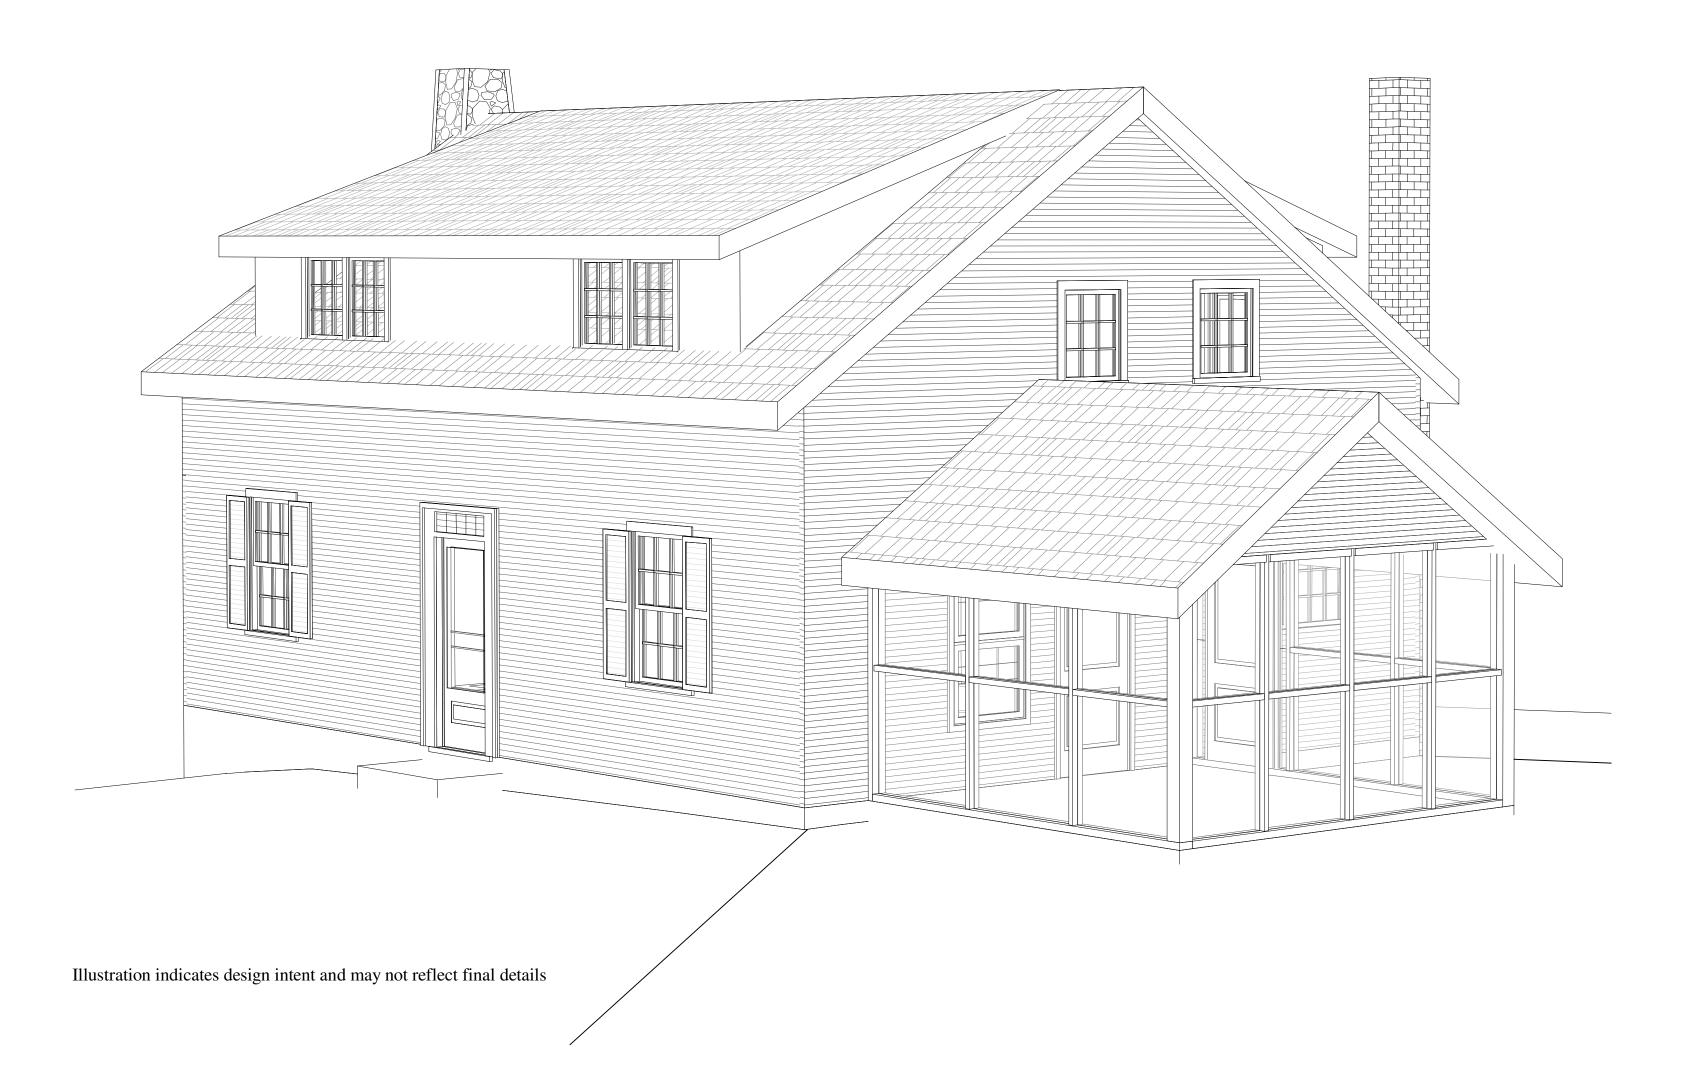

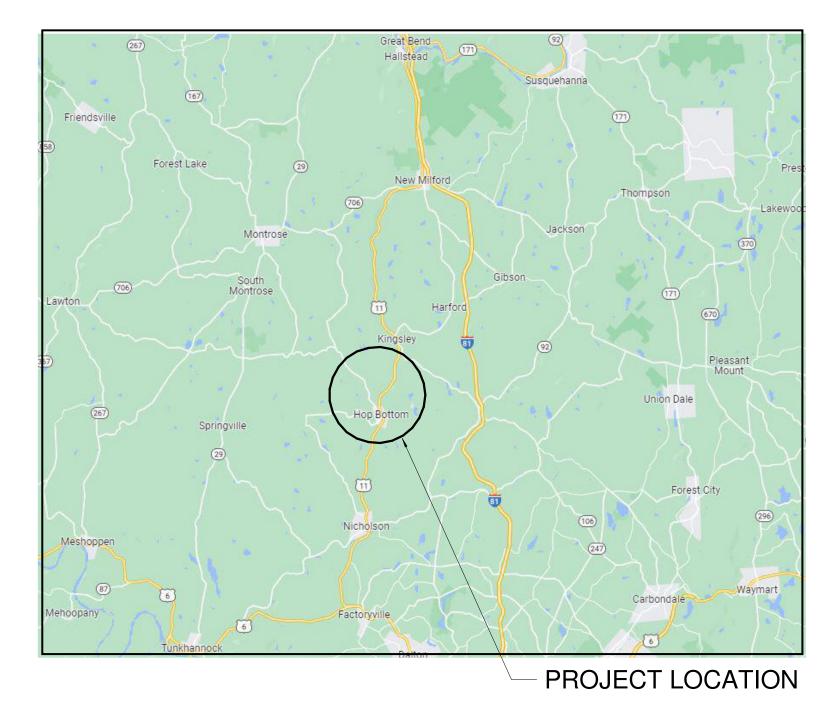

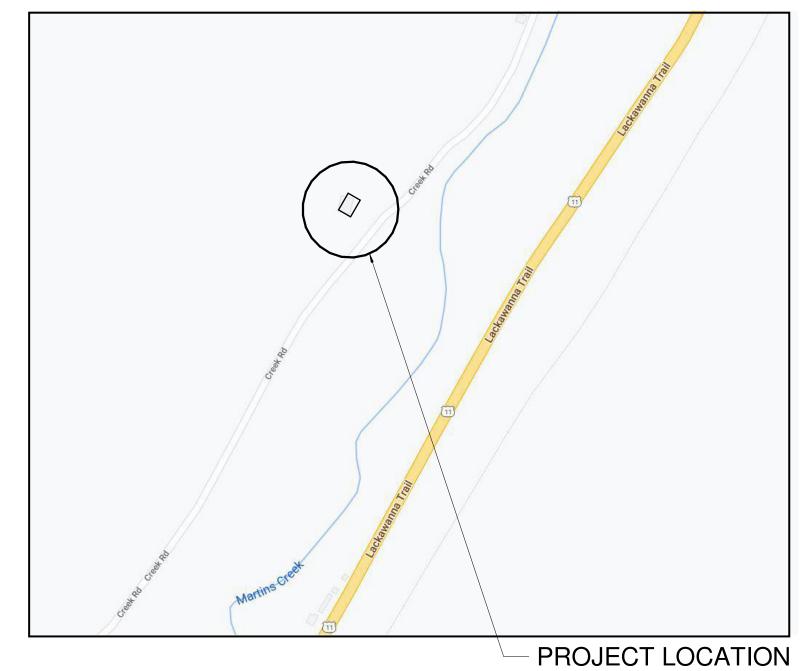

Company Company
No.
AND
Martins Creek Martins Creek Martins Creek

LIST OF SHEETS

C-001

AD-001

A-301

COVER SHEET

SITE PLAN

3D VIEWS

FLOOR PLANS

ELEVATIONS

DEMOLITION PLANS

DEMOLITION ELEVATIONS

ABBREVIATIONS / SYMBOLS / GENERAL NOTES

Discipline

SITE MAP

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Project:

THE DENNIS HOUSE RESTORATION 7799 Creek Road **South of Oakley Crossing** Kingsley, PA 18826

Owner:

Current Issue Date

04/15/22

04/15/22

04/15/22

04/15/22

04/15/22

04/15/22

04/15/22

04/15/22

The Dennis Farm **Charitable Land Trust** P.O. Box 2583 Bala Cynwyd, PA 19004

Revision/Issue:

0 04/15/22 Issued for Review

Reviewed: PY Contact: Philip Yocum, AIA Project Number: 8543.00-21

Sheet Title:

COVER SHEET

Sheet Number:

G-001

Foam Plastic Board

Fire Resistive Joint System

Fiberglass Reinforced

Fire Retardant Treated

ARCHITECTURAL STANDARD ABBREVIATIONS

FRJS

FRP

Alternate

Approximate

Architectural

APPROX

Acoustic Panel Ceiling

BD	Board	FKIW	Fire Retardant Treated	PLBG	Plumbing
BITUM	Bituminous		Wood	PLYWD	Plywood
BLDG	Building	FT	Foot/Feet	PR	Pair
BLKG	Blocking	FTG	Footing	PSF	Pounds Per Square
BM	Beam	FURR	Furring		Foot
BRG	Bearing			PSL	Parallel Strand
BSMT	Basement	GA	Gauge		Lumber
BTWN	Between	GALV	Galvanized	PSI	Pounds Per Square
BUR	Built-up Roofing	GFCI	Ground Fault Circuit		Inch
	1 &		Interrupter	PT	Pressure Treated
CAB	Cabinet	GL	Glass	PTD	Painted
CB	Catch Basin	GR	Grade	PVMT	Pavement
CCTV	Closed Circuit Television	GYP BD	Gypsum Board	1 1111	Tuvellient
CEM	Cement	GII DD	Gypsum Board	R	Riser or Radius
CF/CI	Contractor Furnished/	НВ	Hose Bibb	RD	Roof Drain
CI/CI	Contractor Installed	HC	Hollow Core	REF	Reference
CF/OI	Contractor Furnished/	HDW	Hardware		
CF/OI				REFR	Refrigerator
CI	Owner Installed	HDWD	Hardwood	REINF	Reinforced
CI	Cast Iron	HM	Hollow Metal	REQD	Required
CIP	Cast-in-place	HORIZ	Horizontal	RES	Resilient
CJ	Control Joint	HP	High Point	RM	Room
CLG	Ceiling	HPC	Handicapped	RO	Rough Opening
CL	Closet	HR	Hour	RWC	Rain Water
CLR	Clear	HSKPG	Housekeeping		Conductor
CMU	Concrete Masonry Unit	HSS	Hollow Structural Section		
CNTR	Center		(Tube Steel)	S	South
COL	Column	HT	Height	SC	Solid Core
CONC	Concrete		_	SCHED	Schedule
CONST	Construction	ID	Inside Diameter	SECT	Section
CONT	Continuous	IN	Inch(es)	SF	Square Feet
CORR	Corridor	INCL	Included	SFRM	Spray Fire Resistive
CPT	Carpet	INS	Insulation	STIG	Materials
CRS	Course(s)	INT	Interior	SIM	Similar
CT	Ceramic Tile	1111	Interior	SPEC	Specification
CI	Ceranne The	JAN	Janitor	SPM	Single Ply Membrane
DBL	Double	JST	Joist		•
DEPT		JT	Joint	SQ	Square Stainless Steel
DET	Department Detail	JI	Joint	SS	
		LAD	Laboratam	STD	Standard
DF	Drinking Fountain	LAB	Laboratory	STL	Steel
DIA	Diameter	LAM	Laminate	STOR	Storage
DIM	Dimension	LAU	Laundry	STRUCT	Structure
DN	Down	LAV	Lavatory	SUSP	Suspended
DS	Downspout	LNDSCP	Landscape		
DWG	Drawing	LP	Low Point	T	Tread
		LTTR	Long Term Thermal	T&G	Tongue & Groove
E	East		Resistance	TEL	Telephone
EA	Each	LVL	Laminated Veneer Lumber	THK	Thick
EIFS	Exterior Insulation and			TO	Top Of
	Finish System	MAX	Maximum	TOC	Top Of Concrete
EJ	Expansion Joint	MDF	Medium Density	TOF	Top Of Finish
EL	Elevation		Fiberboard	TOM	Top Of Masonry
ELEC	Electrical	MECH	Mechanical	TOS	Top Of Steel
ELEV	Elevator	MEP	Mechanical, Electrical,	TPO	Thermoplastic
EMER	Emergency	1,122	Plumbing	110	Polyolefin
EOS	Edge of Slab	MFR	Manufacturer	TYP	Typical
EPDM	Ethylene Propylene	MIN	Minimum	1 1 1	Typical
LI DIVI	Diene Monomer	MISC	Miscellaneous	LINO	Unless Noted
EPS				UNO	Unless Noted
LFS	Expanded Polystyrene	MO MT	Masonry Opening Marble Threshold		Otherwise
EO	Insulation	MT MTD	Marble Threshold		W:10
EQUID	Equal	MTD	Mounted	VCT	Vinyl Composition
EQUIP	Equipment	MTL	Metal	·	Tile
ETR	Existing to Remain	MUL	Mullion	VERT	Vertical
EWC	Electric Water Cooler			VEST	Vestibule
EXIST	Existing	N	North	VIF	Verify In Field

North

Number

Nominal

Not To Scale

Occupant(s)

Outside Diameter

Owner Furnished

Owner Furnished

Owner Installed

Overhead

Opening

Opposite

Contractor Installed

Oriented Strand Board

On Center

Not Applicable

Not In Contract

NA

NIC

NO

NOM

NTS

OC

OD

OH

OPG

OPP

OSB

VIF

W/

WC

WD

WH

WP

WSCT

WT

XPS

WWF

W/O

Verify In Field

With

Without

Wood

Barrier

Wainscot

Insulation

Water Closet

Water Heater

Walk-in-Closet

Working Point

Water-Resistive

Welded Wire Fabric

Extruded Polystyrene

THE DENNIS HOUSE RESTORATION

The Historic Dennis Farm 7799 Creek Road **South of Oakley Crossing** Kingsley, PA 18826

The Dennis Farm Charitable Land Trust

P.O. Box 2583 Bala Cynwyd, PA 19004

Precast Concrete

Containment System

Perimeter Fire

Plastic Laminate

Plate

Plumbing

PCFS

PLAM

PLBG

PL

Architect: Consultant to Owner **BERNARDON** 123 Justison Street, Suite 101 Wilmington, DE 19801 T 302-622-9550 F 302-622-9554 Contact: Philip Yocum, AIA Email: pyocum@bernardon.com

MEP Engineer: Consultant to Architect **BRUCE E. BROOKS & ASSOCIATES**

2209 Chestnut Street

Philadelphia, PA 19103 T: 215-569-0400 F: 215-569-2664

Structural Engineer: Consultant to Architect

KEAST & HOOD 1635 Markey Street

Suite 1705 Philadelphia, PA 19103 T: 215-625-0099

KEY INFORMATION

1. Applicable Code(s) & Regulations For This Project.

State: [PA ONLY PROJECTS - STATEWIDE, EXCEPT PHILADELPHIA] 2018 IRC (International Residential Code with Amendments) **2018 IECC (International Energy Conservation Code)** PA Uniform Construction Code (Regulations and Statutes) [Review Latest] [(If in a flood zone) FEMA (Federal Emergency Management Agency) regulations and National Flood Insurance Program (NFIP) Technical Bulletins] [(If project site is governed by an HOA) [Homeowners' Association Name] covenants and restrictions]

Susquehanna County Building Code (Chapter 6 of NCC Municipal Code) Susquehanna County Development of Land Use - Historic Review Board Secretary of the US Department of the Interior's Standards and Guidelines for Rehabilitating **Historic Buildings**

2010 ADA (Standards for Accessible Design)

- 4. Occupancy Use Classification(s):
- 5. Construction Type(s) / Classification(s):
- 6. Project Description:
- 7. Date(s) of Original Construction:
- 8. Building Code Details: See Code Summary [on following G-Series Sheet(s).]
- 9. Zoning Code Details:
- 10. Climate Zone: #
- 11. Authority Having Jurisdiction: Susquehanna County
- 12. Fire Protection Systems:
- 13. Automatic Sprinkler System:
- 14. Level of Alteration: Section 607 Historic Buildings; 607.1 Scope Historic building provisions shall apply to buildings classified as historic as defined in Chapter 2. 607.2 Application Except as specifically provided for in Chapter 12, historic buildings shall comply with applicable provisions of this code for the type of work being performed.
- 15. Information:

STANDARD GENERAL NOTES

- 1. The Specifications are that portion of the Contract Documents consisting of the written requirements for materials, equipment, systems, standards and workmanship for the Work, and the performance of related services. Whether printed or in portable document format (PDF), the Specifications that have been prepared as a letter-size manual complement the Drawings bound herein, and what is required by one shall be as binding as if required by all.
- 2. All work shall be in accordance with applicable state and local building codes and all other governing agencies and regulations.
- 3. Contractor shall verify all conditions and dimensions in the field prior to commencement of the work. Verify layout in relation to property, benchmarks, and other fixed conditions. Report discrepancies to the Architect immediately upon discovery.
- 4. Notify Architect of discrepancies regarding the Contract Documents or design intent immediately upon discovery Contractor shall be responsible for obtaining clarification prior to proceeding with the work or related work.
- 5. Contractor shall obtain all required building permits and licenses.
- 6. Contractor shall remove all rubbish and debris from the site during course of project, and dispose of legally off-
- 7. Contractor shall perform all cutting, patching and protection required to complete the work indicated on the Contract Documents.
- 8. Contractor shall provide all inspections and tests required by state and local authorities including but not limited to earthwork, concrete, steel erection, mechanical, plumbing, and electrical work. Refer to individual drawings and specifications for additional testing requirements.
- 9. Unless indicated otherwise in Specifications, products and manufacturers are noted to establish the type and quality of materials to be provided. Contractor may submit proposed substitutions to the Architect for review, with enough supporting data provided for the Architect to make an evaluation. Contractor shall include costs associated with proposed substitution, including redesign, and alteration of adjacent work to accept substitution.
- 10. All dimensions are either to face of masonry or the face of stud, unless noted otherwise. Drawings are not to be
- 11. Install all equipment and materials per manufacturer's instructions and recommendations unless specifically otherwise indicated, or where local codes and regulations take precedence.
- 12. Contractor shall provide supervision while any subcontractors or workers are on the job site and shall supervise and direct all work.
- 13. Contractor shall be solely responsible for all construction means, methods, techniques, sequences, procedures, site safety, erosion and sedimentation control, and coordinating the work of all trades under the contract.
- 14. No products containing asbestos or other hazardous materials shall be installed on this project or used during the construction of the project. It shall be the responsibility of the Contractor to certify to the Owner that this requirement has been met. Subcontractors shall verify to the Contractor that no asbestos or other hazardous products are used in their work.
- 15. Locations of rated fire/smoke separations and/or fire resistive structural protection are shown on documents. Provide complete assemblies to meet fire resistive requirements of the project including protection of structural elements and fire separation assemblies. Maintain the integrity of these assemblies at openings and penetrations including but not limited to fire or smoke dampers in ductwork, light fixture protection, electrical device box ratings, expansion joints, and sealants. Provide this protection by using complete building component systems approved by recognized authorities such as Underwriters Laboratories, Inc., Factory Mutual, or other building code accepted agencies. It is the responsibility of the Contractor to coordinate subcontractors and suppliers to accomplish this work during bidding, procurement, scheduling, sequencing and construction of the project.

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West Chester, Pennsylvania

Philadelphia, Pennsylvania

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Project:

THE DENNIS HOUSE RESTORATION 7799 Creek Road **South of Oakley Crossing** Kingsley, PA 18826

Owner:

The Dennis Farm **Charitable Land Trust** P.O. Box 2583 Bala Cynwyd, PA 19004

Revision/Issue:

0 04/15/22 Issued for Review

PY Reviewed: Philip Yocum, AIA Contact: Project Number: 8543.00-21

Sheet Title:

ABBREVIATIONS / SYMBOLS / GENERAL NOTES

Sheet Number:

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EXIST

FD

FHC

FIN

FIXT

FOS

FLUOR

Existing

Exterior

Expansion

Fire Alarm

Floor Drain

Foundation

Fixture

Floor

Fluorescent

Fire Extinguisher

Fire Hose Cabinet

Face Of Concrete

Face Of Finish

Face Of Studs

Face Of Masonry

Fire Extinguisher Cabinet OCC

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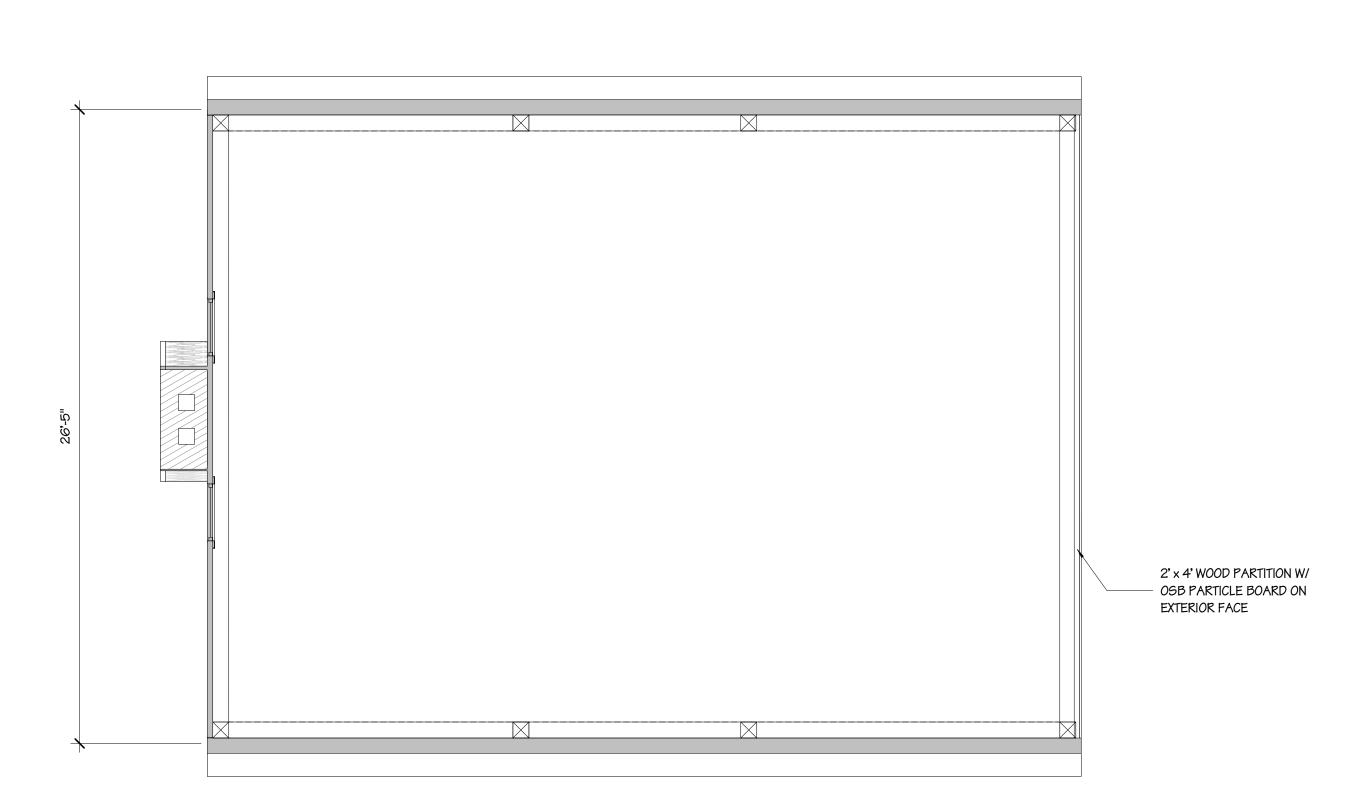
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Reviewed: PY
Contact: Philip Yocum, AIA
Project Number: 8543.00-21

Sheet Title:
SITE PLAN

Sheet Numb

C-001







02 SECOND F

02 SECOND FLOOR PLAN

SCALE 1/4" = 1'-0"

0' 2' 4'

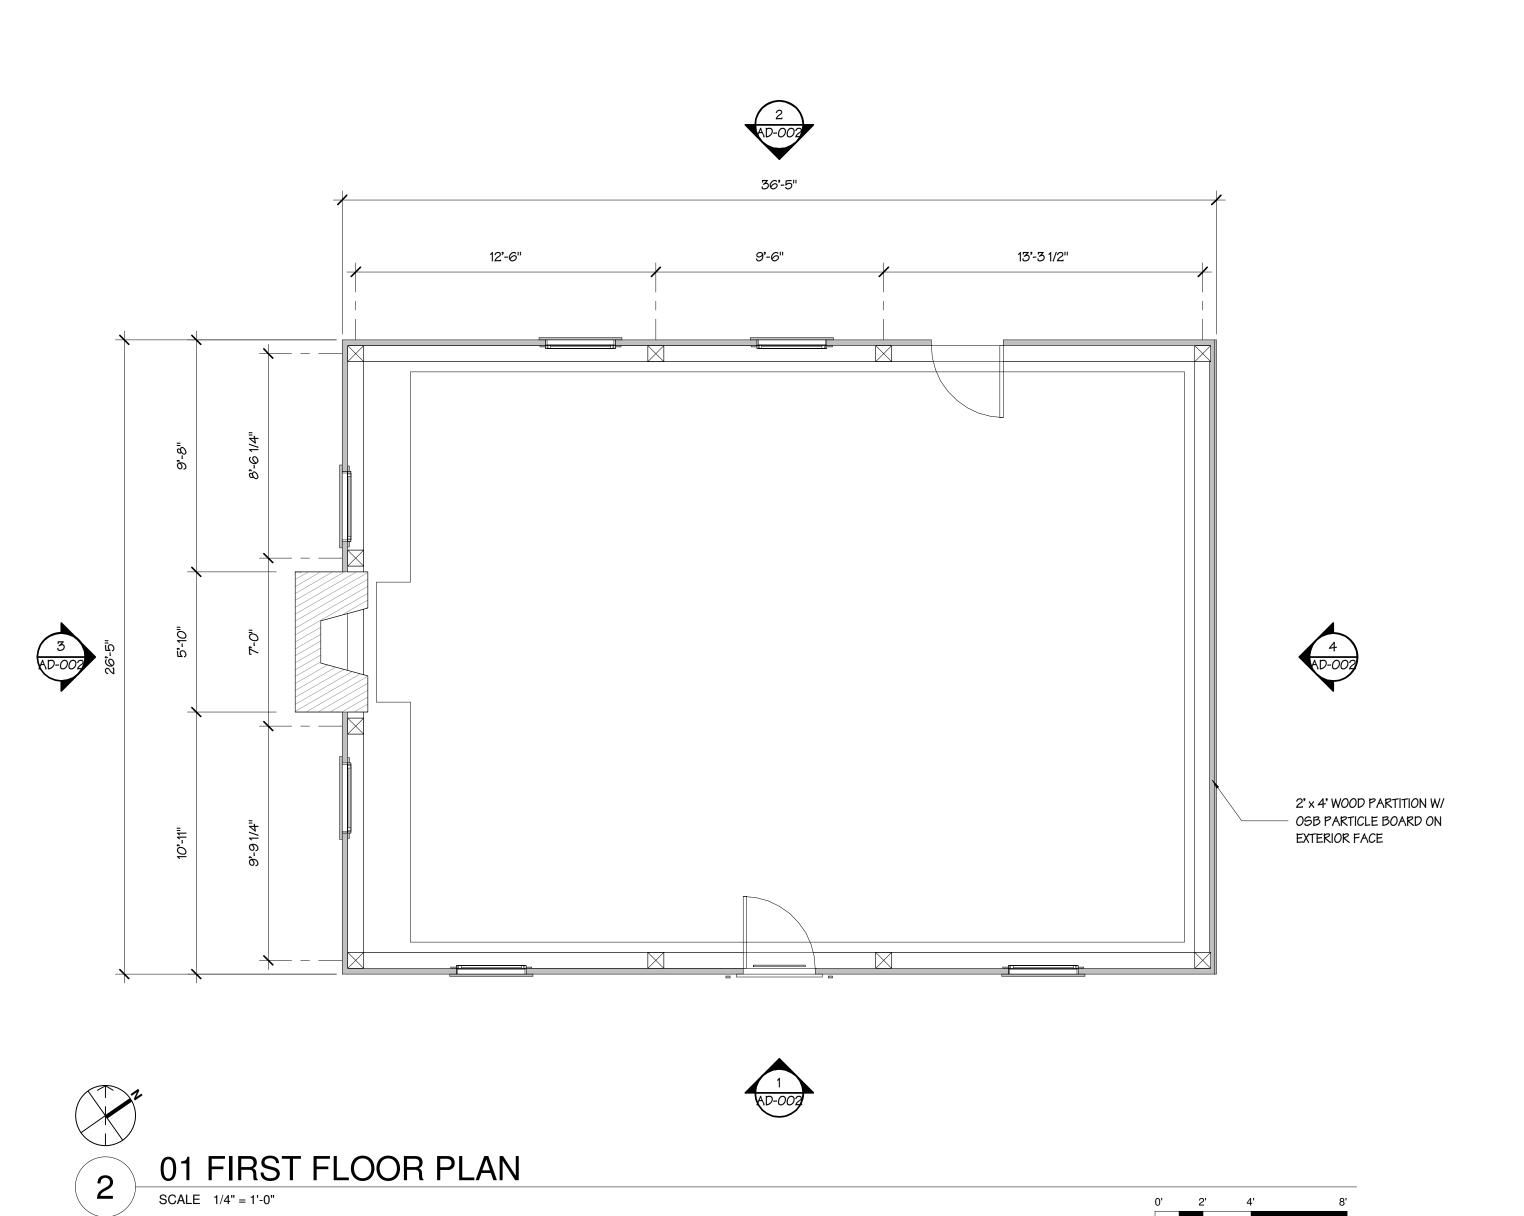

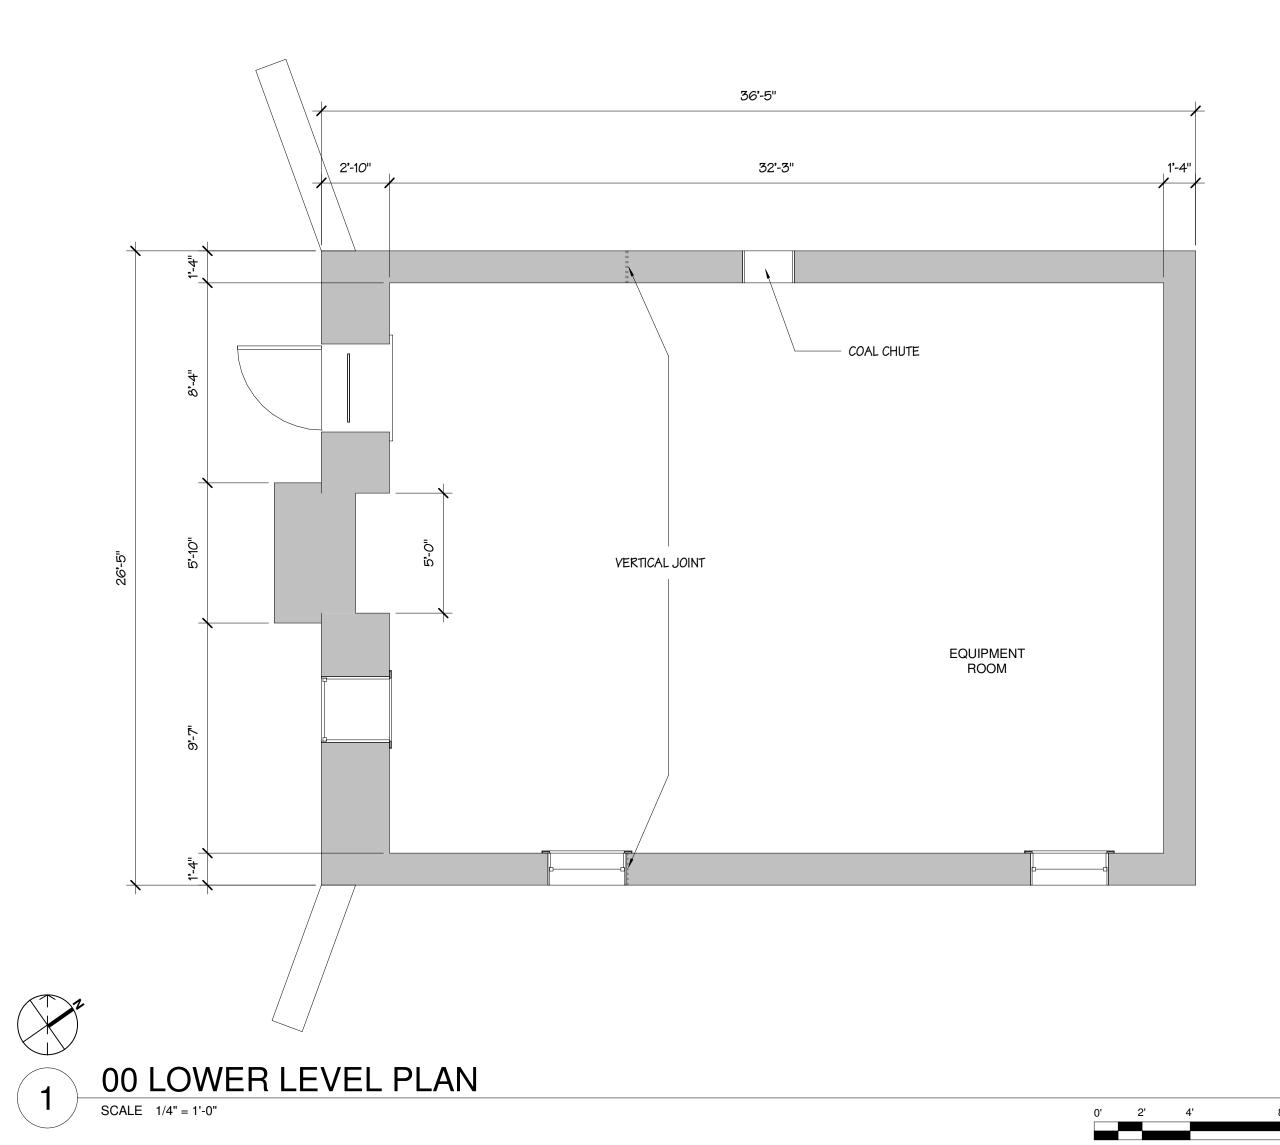

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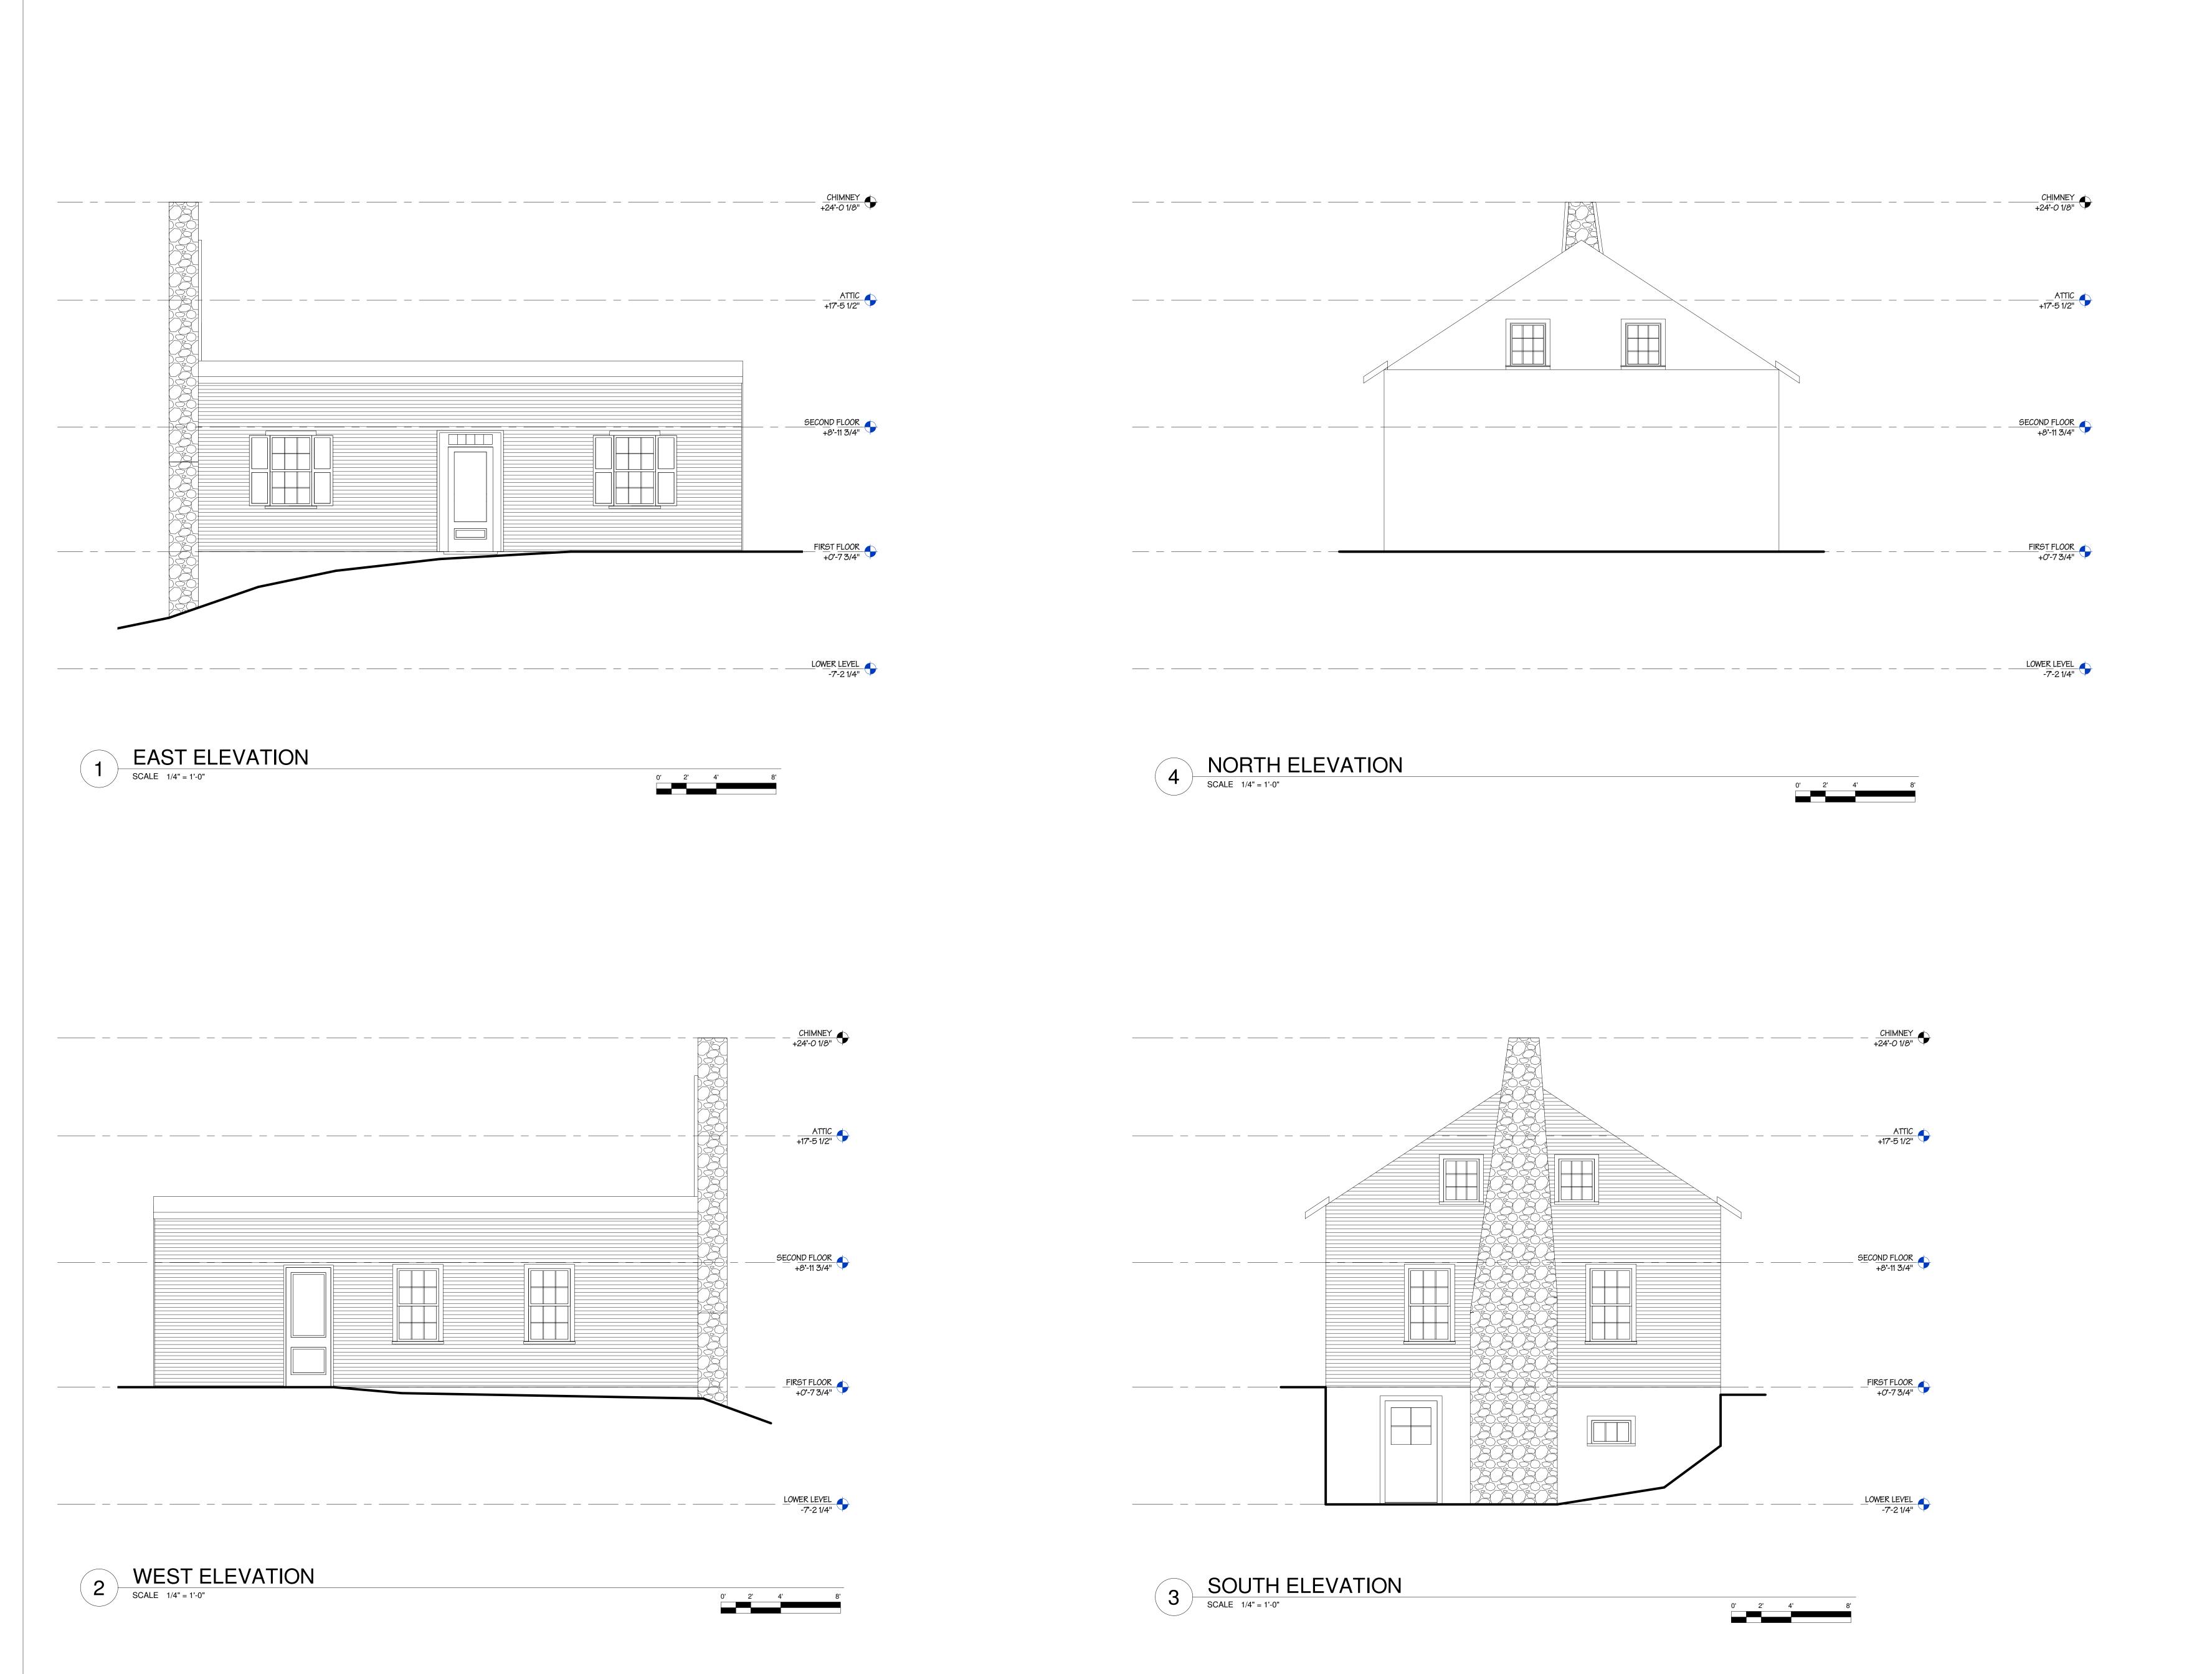
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Reviewed: PY
Contact: Philip Yocum, AIA
Project Number: 8543.00-22

Sheet Title:

DEMOLITION PLANS

Sheet Number:





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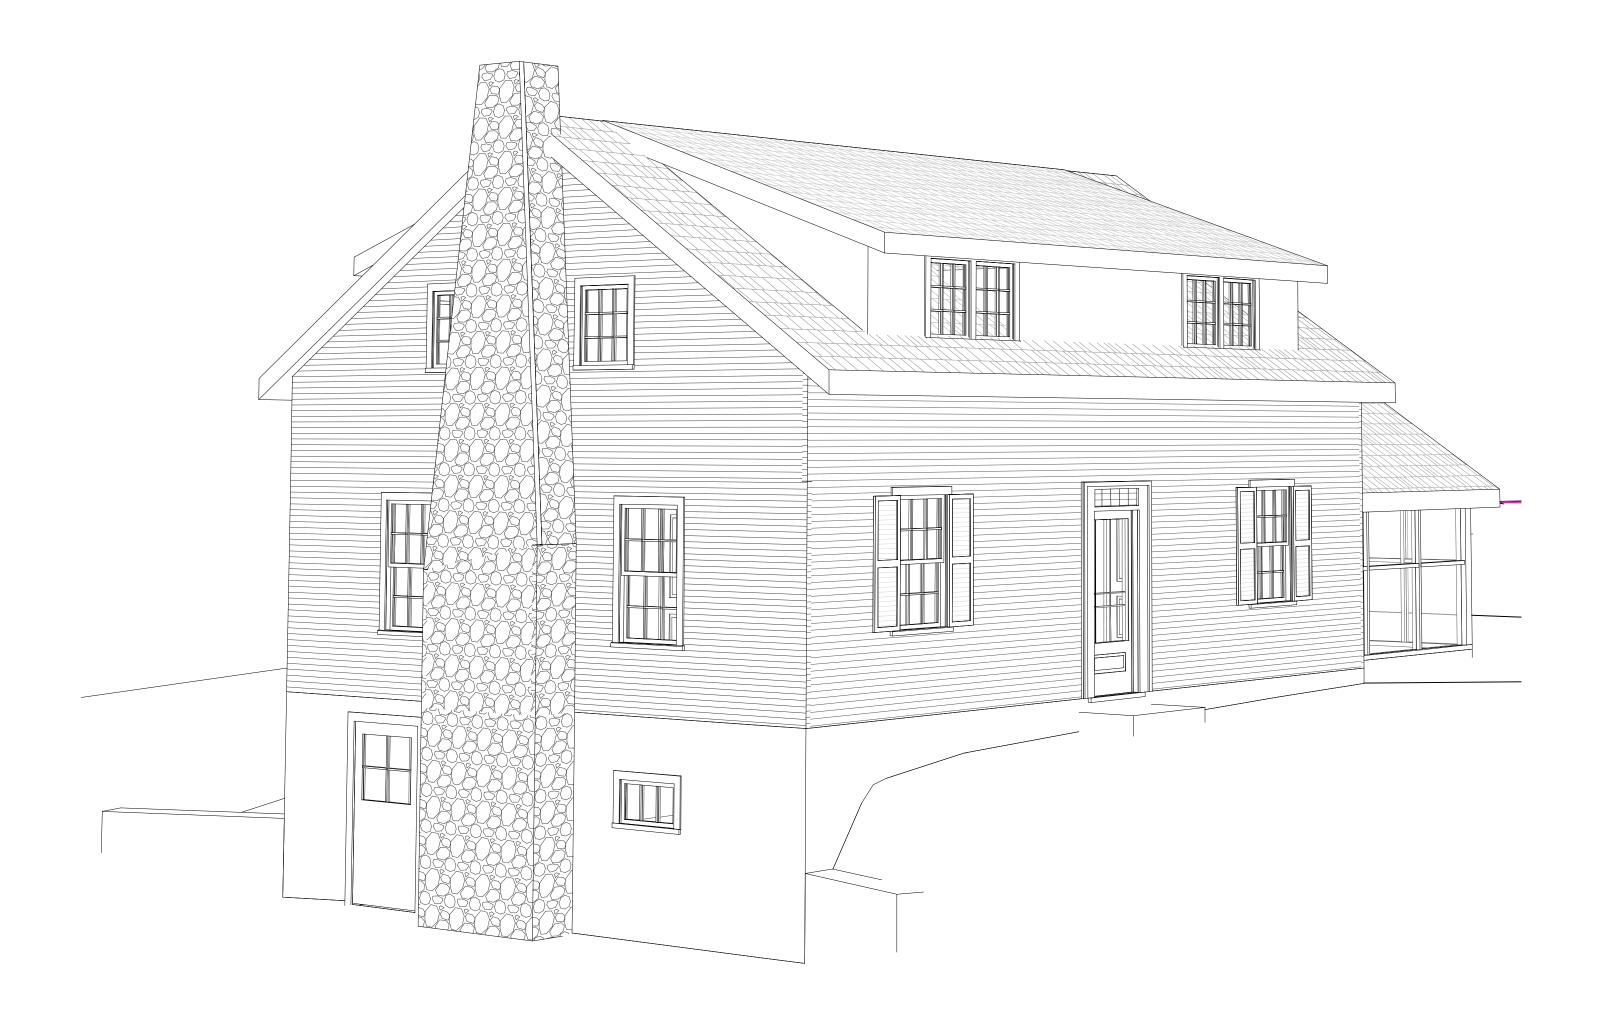
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DEMOLITION
ELEVATIONS

Sheet Number:


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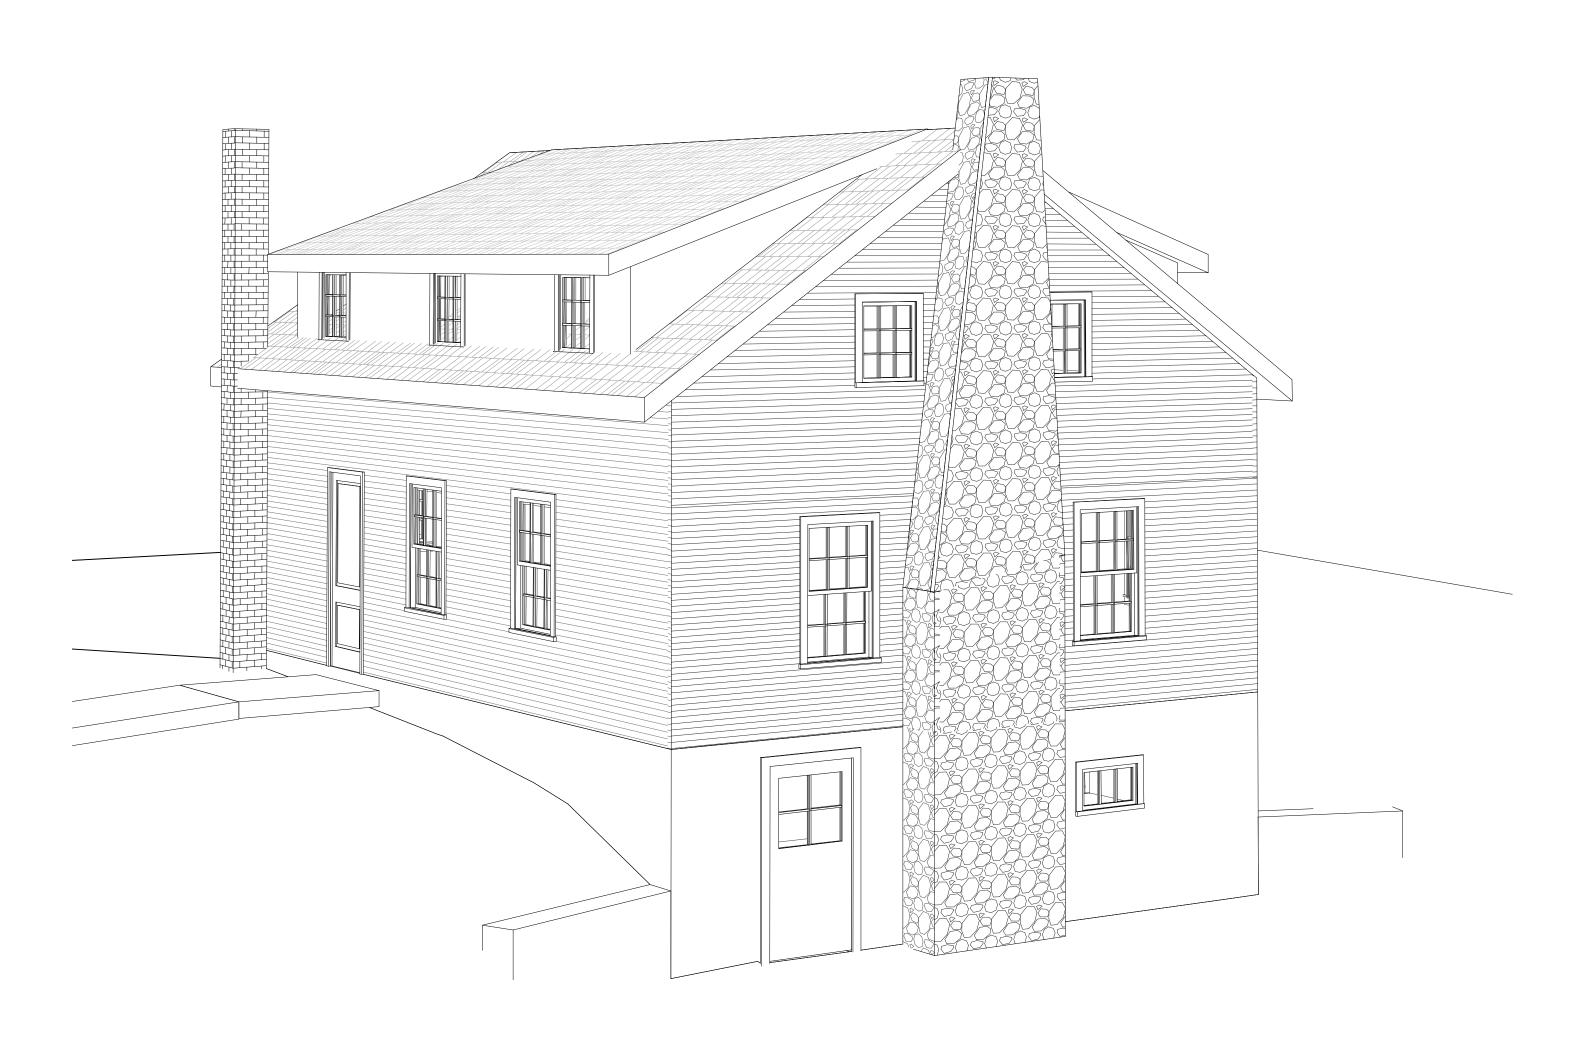






4 3D VIEW - SOUTHEAST
SCALE



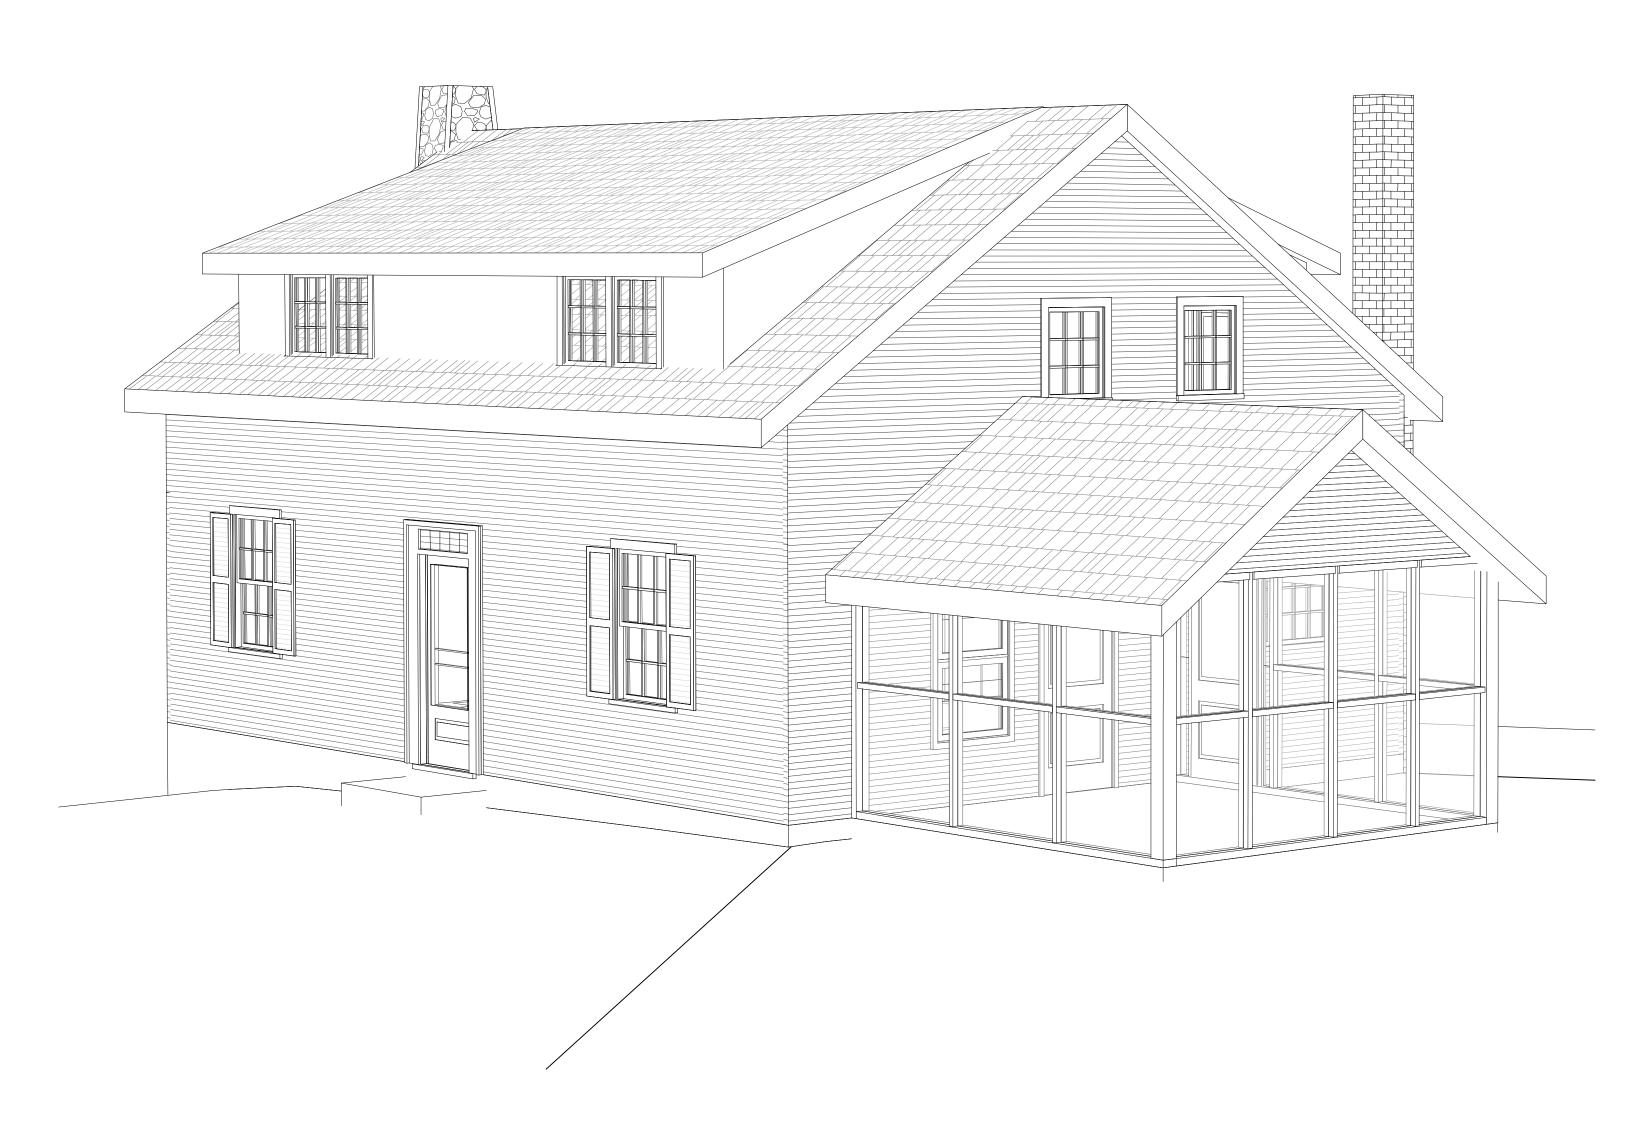

1 3D VIEW - NORTHEAST SCALE

3 SCALE SOUTHWEST

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South of Oakley Crossing
Kingsley, PA 18826

Owner:

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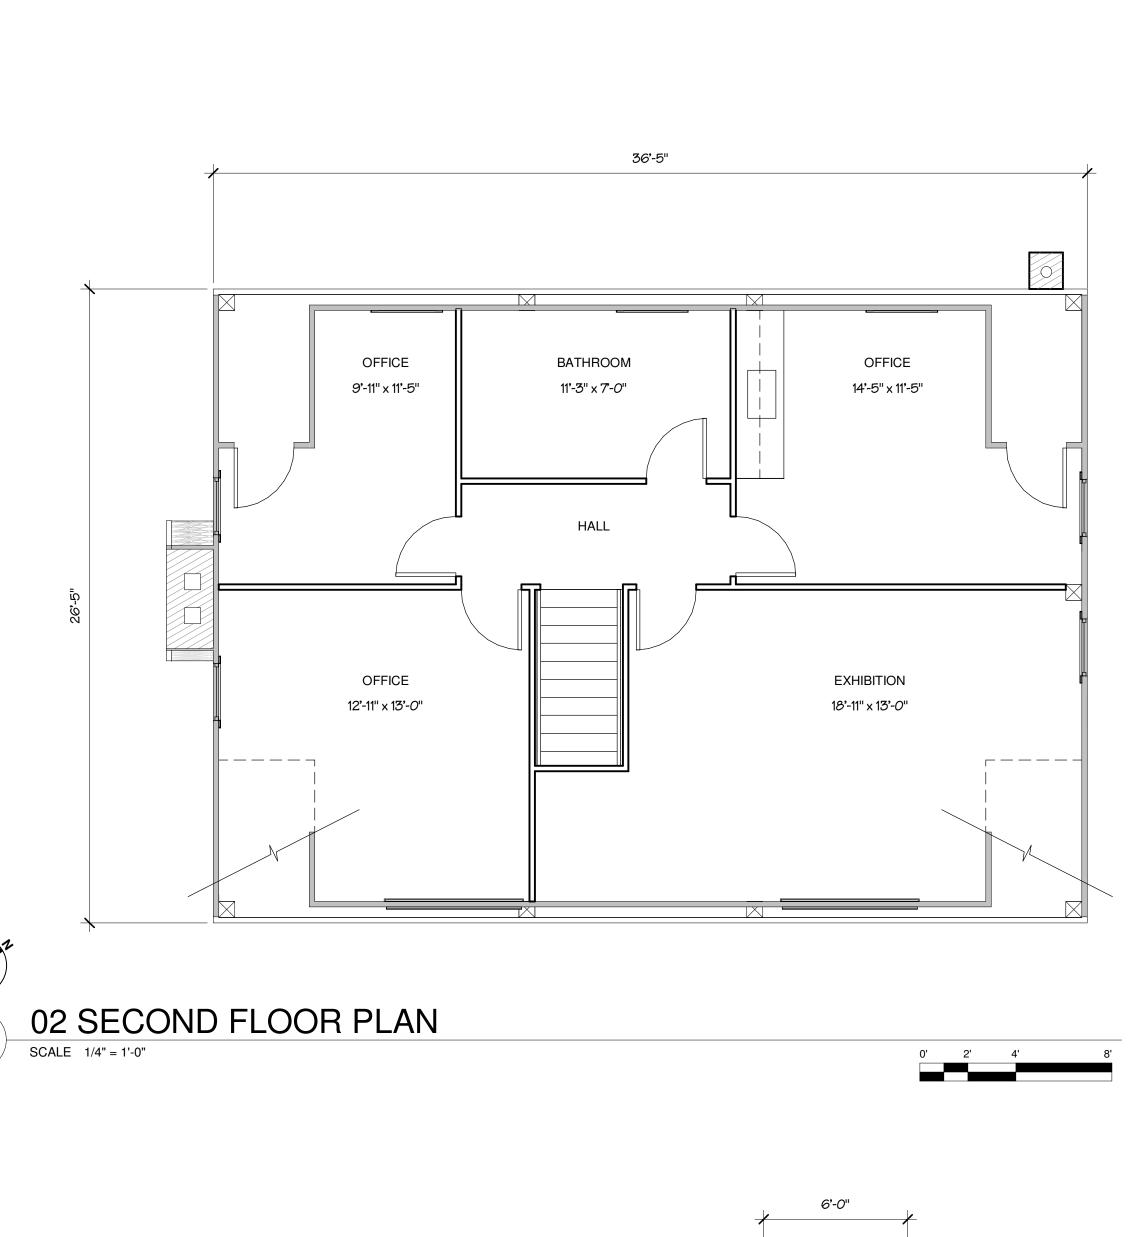
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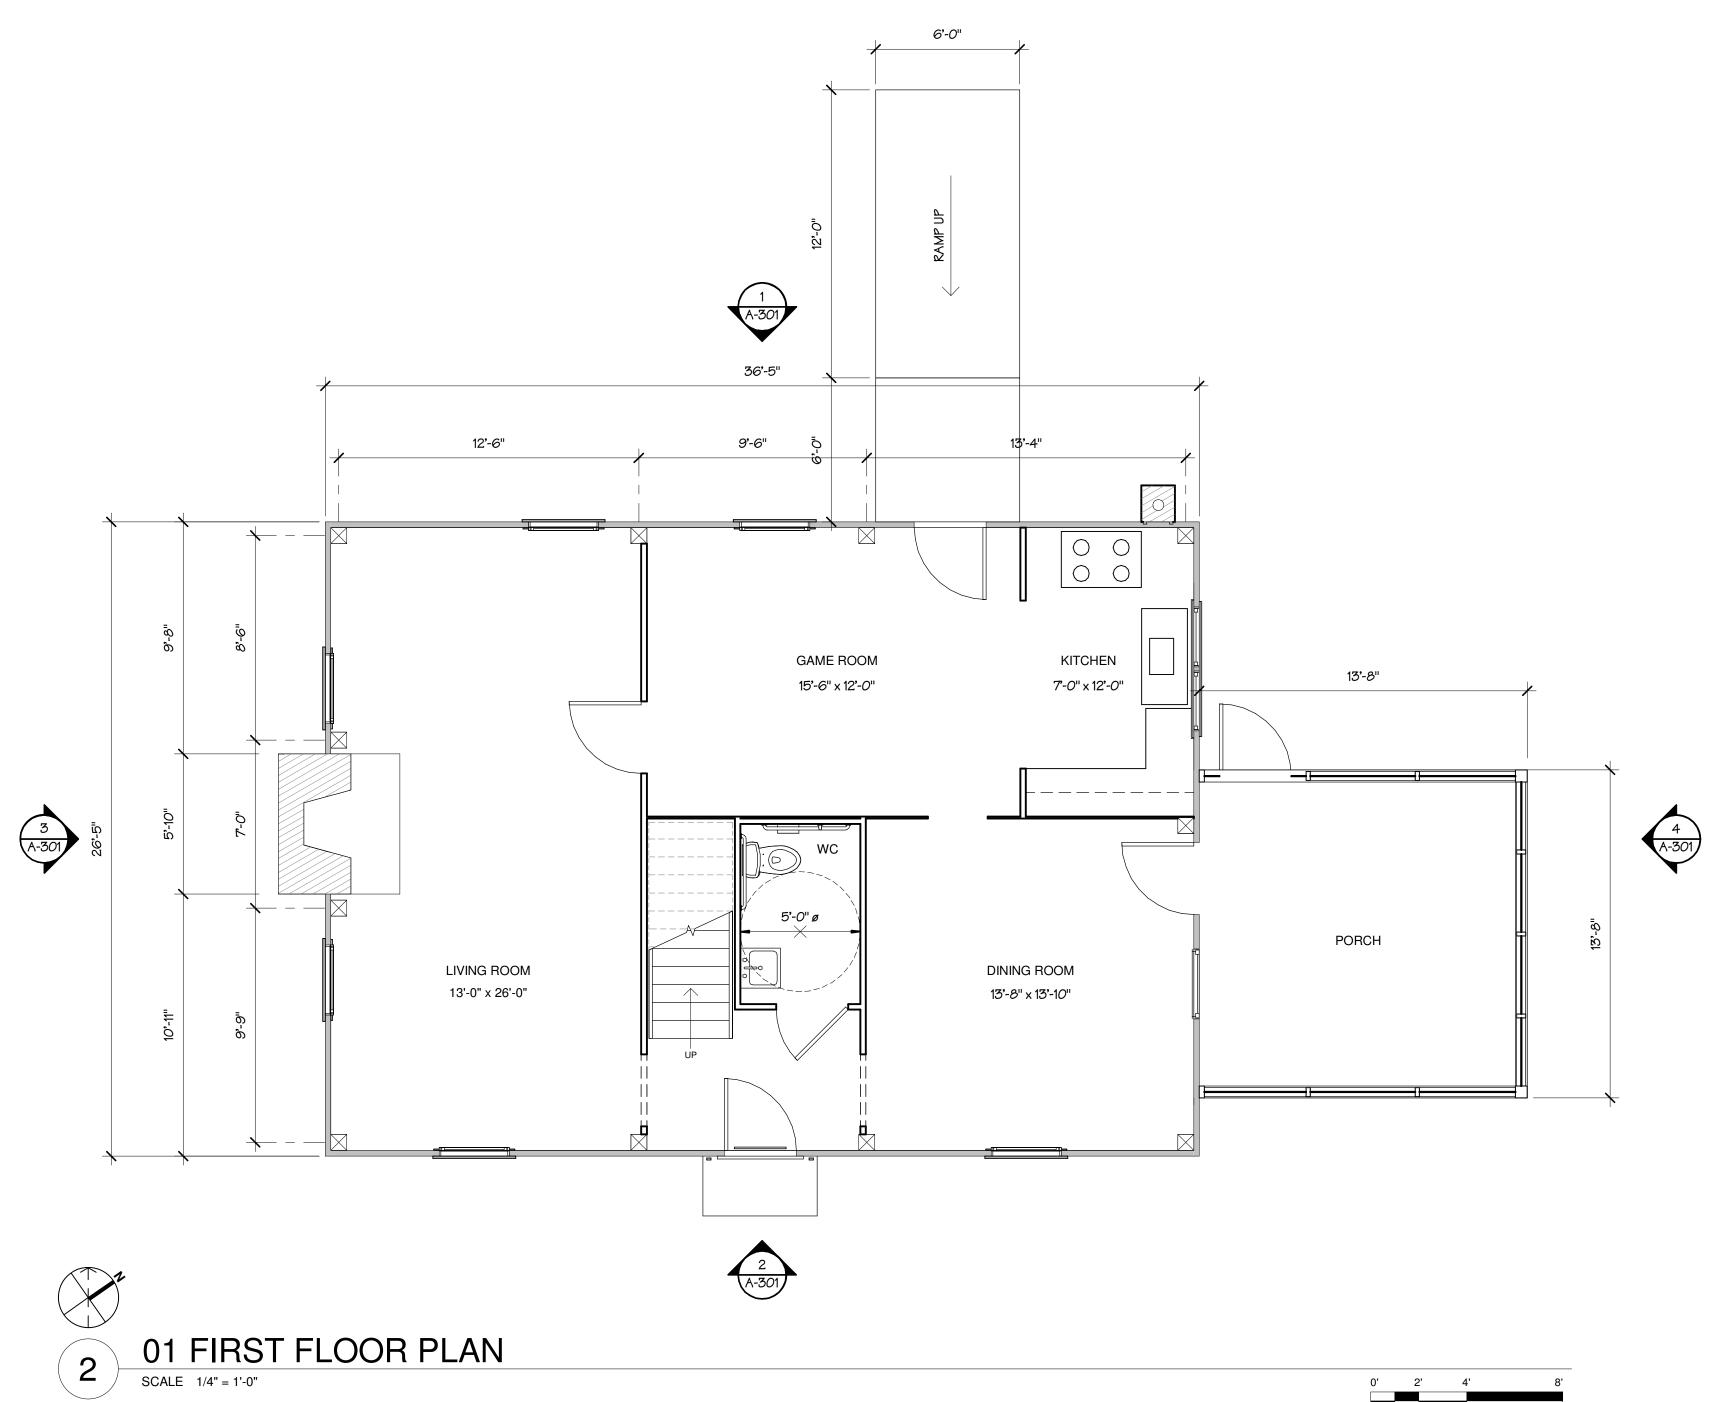
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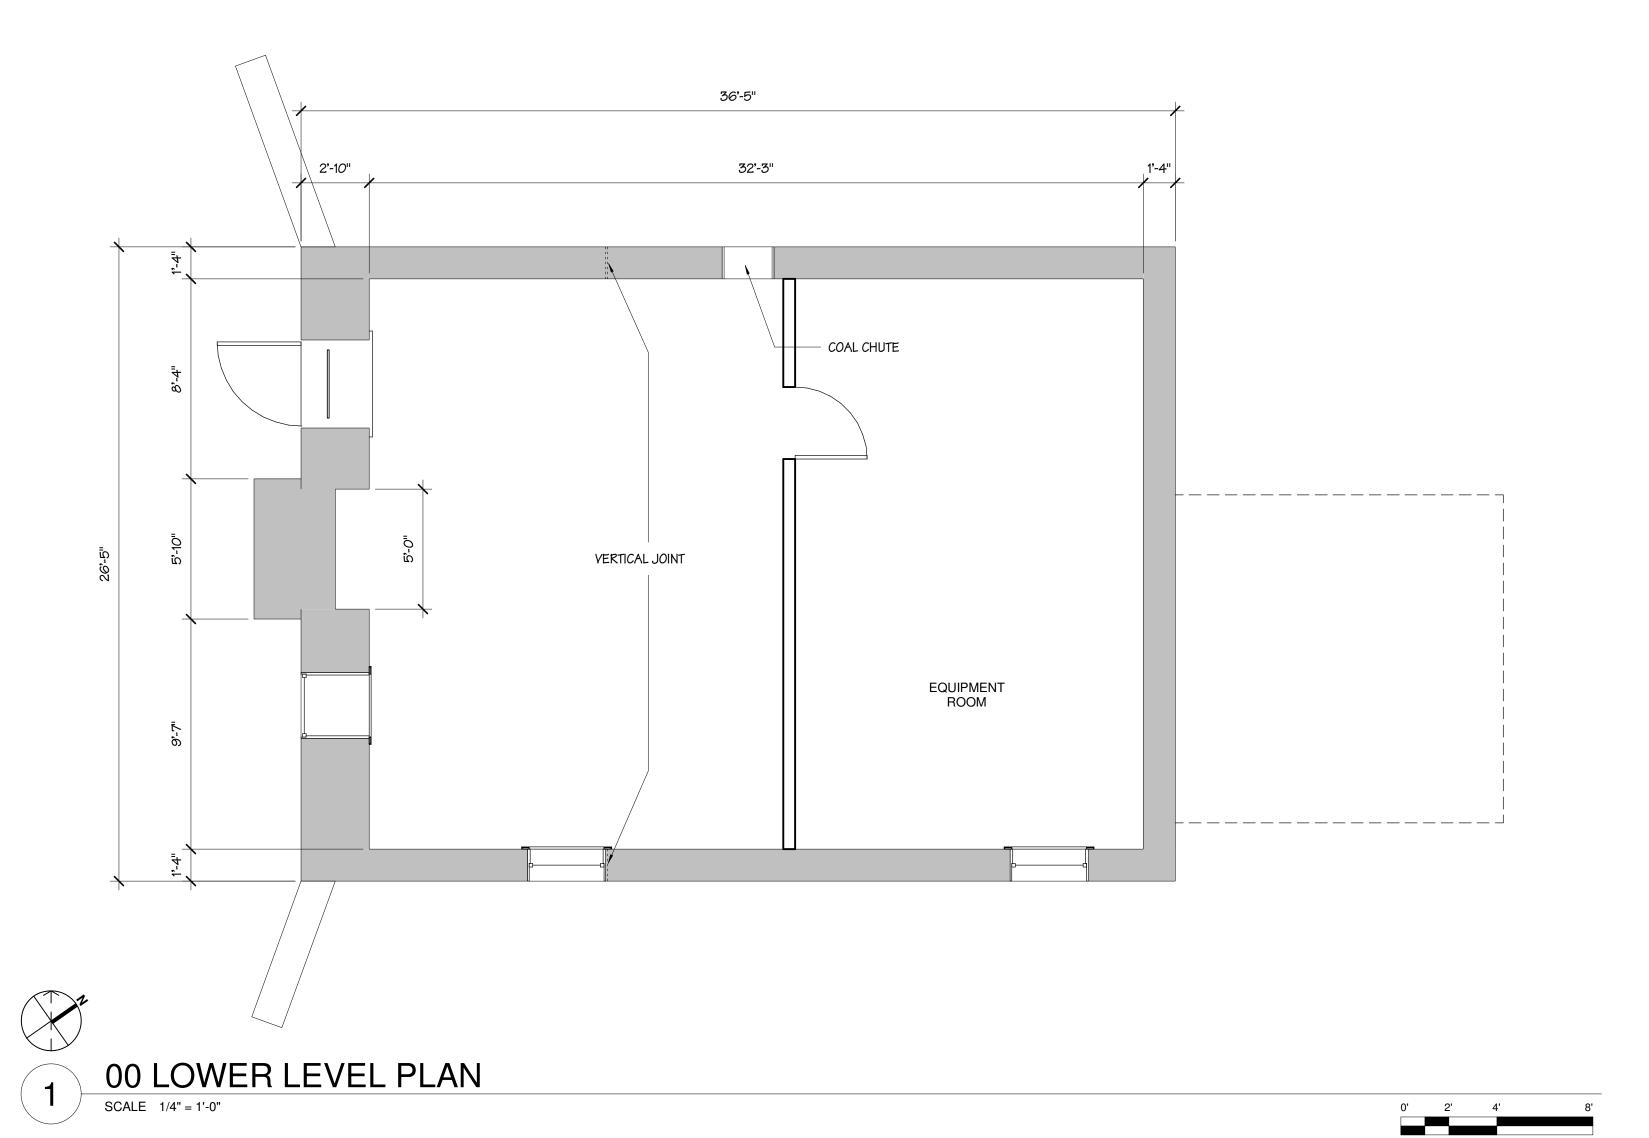
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Sheet Title: 3D VIEWS

Sheet Number:







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Contact: Philip Yocum, AIA
Project Number: 8543.00-21

Sheet Title:

FLOOR PLANS


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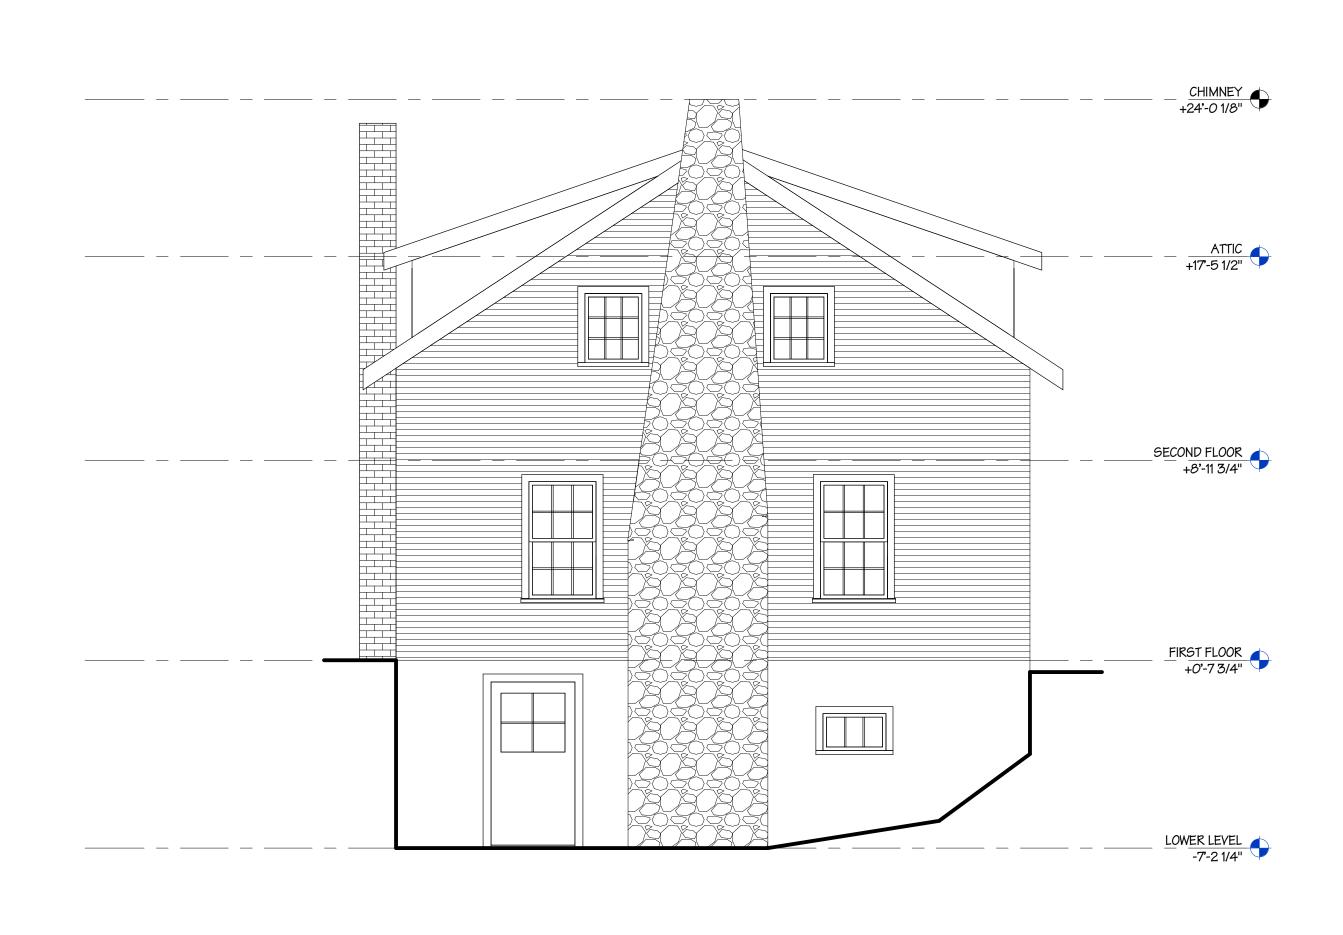
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Contact: Philip Yocum, AIA
Project Number: 8543.00-21

Sheet Title: ELEVATIONS

Sheet Number:

A-301

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1 WEST ELEVATION

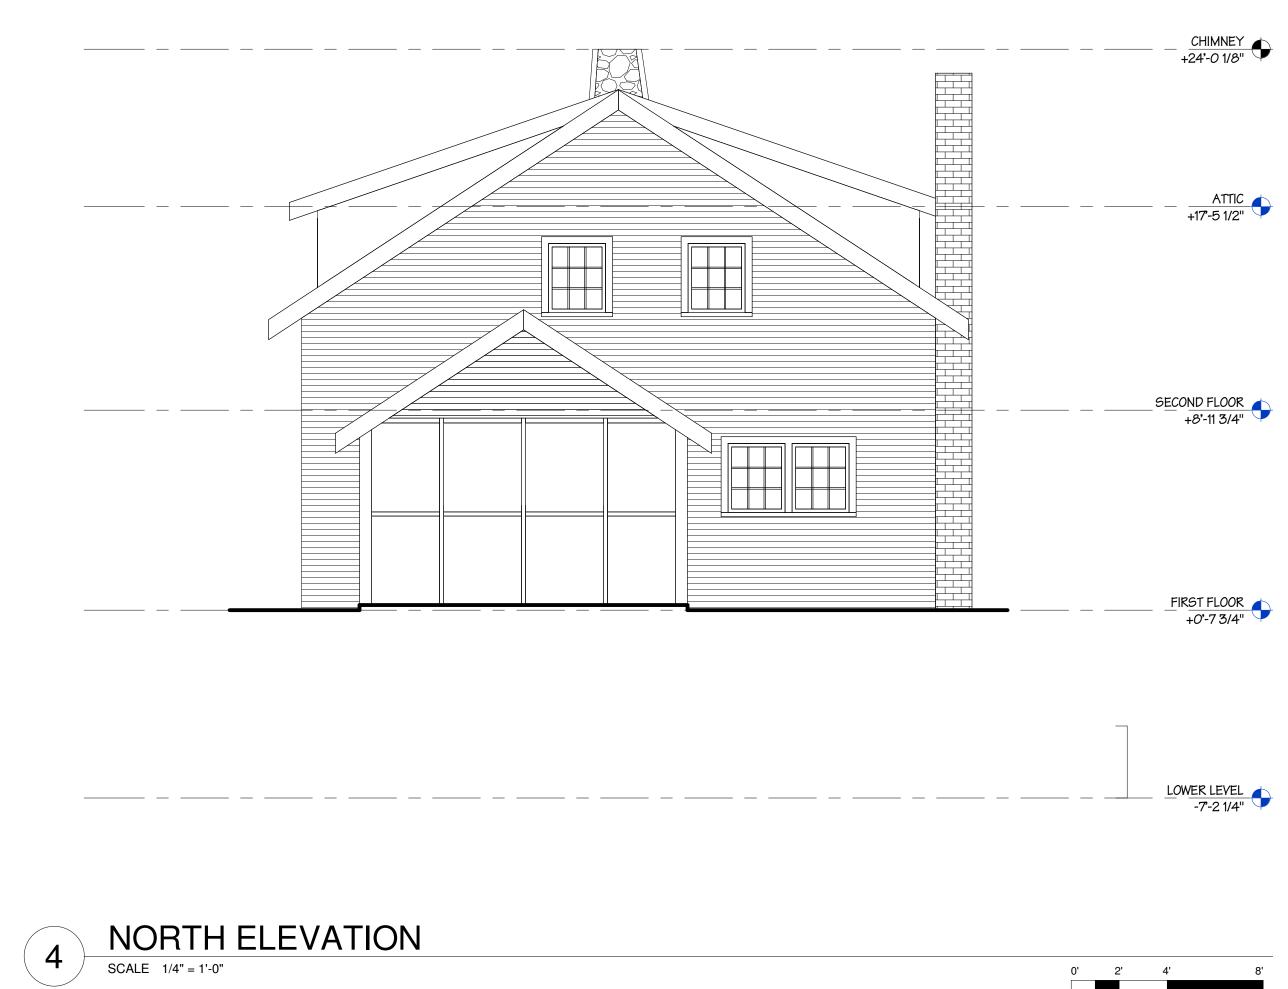SCALE 1/4" = 1'-0"